



**ADDENDUM NO. 1**

To the Bid Documents For:

**Storefront Window Replacement @ William Guste School**

**Project #ITB24-FAC-0015**

2625 Thalia Street

New Orleans, LA 70113

The following list of revisions and/or enclosures alters and modifies the above referenced plans and specifications issued for construction 07/05/2024.

The provisions of all the Contract Documents are hereby made a part of this revision to the plans and specifications.

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**ENCLOSURES:**

Item	Date	Description
G000 TITLE SHEET	08/26/2024	Revise Sheet Index to indicate revised drawings sheets
A302 OPENING SCHEDULE AND DETAILS	08/26/2024	Revise Storefront sill detail 1/A302. Add Aluminum trim piece to all new sills.
A302 OPENING SCHEDULE AND DETAILS	08/26/2024	Clarify graphic representation of existing structure 1/A302 and 3/A302
Pre-Bid Meeting	08/22/2024	Meeting Minutes

**BIDDER QUESTIONS:**

**Item 1.** Construction schedule

**Q:** Are there restrictions on the contractor’s access to the site?

**A:** No construction work to take place while students are in school. Construction is limited to vacations, breaks, weekends and after school hours. School day ends 3pm. For school schedule see Project Manual page 01 10 00 4 of 7. Dates are subject to change and GC bidder shall verify with Facilities Manager.

- Fall Break - Monday 10/14 through Friday 10/18
- Thanksgiving Break - Monday 11/25 through Friday 11/29
- Winter Break - Monday 12/23 through Friday 1/3

**Item 2.** Existing wall assembly

**Q:** What is the wall construction assembly?

**A:** CMU back up wall at sills and base of doors. Typical jambs and heads are at structure. Clarification that structure is concrete. See revised sheet A302 as part of this Addendum.

**Item 3.** Available funds for construction

**Q:** What are the available funds for construction?

**A:** \$225,000-250,000.

**Item 4.** Contract duration

**Q:** What is the contract duration for construction?

**A:** Construction duration is 120 days. See Project Manual Page IB-3

END OF ADDENDUM

## Guste Storefront Replacement Pre-Bid Meeting

Meeting Date: 8/22/24  
Meeting Time: 10amCT  
Location: Project Site 2625 Thalia St.

### SIGN IN SHEET

NAME	ROLE, ORGANIZATION	Phone	Email
Mike Berkowitz	Smith Construction Co.	985-882-2426	mike@smithcc.net
Kelsey Troclair	Tuna Construction	504-305-2249	bids@tunaconstruction.com
Ray Lauga	Atlas /OPSB	504-390-8731	Ray.lauga@oneatlas.com
Kristin McAllister	Atlas/ OPSB	504.975.5748	<a href="mailto:Kristin.mcallister@oneatlas.com">Kristin.mcallister@oneatlas.com</a>
Kathleen Welch	Facilities Manager, Opportunities Academy		
Elizabeth Chen	Architect, Concordia LLC	504.702.6825	echen@concordia.com

### AGENDA

- Introductions
- Review of project scope and discussion
- Review of Schedule
- Site walkthrough

### MEETING MINUTES

- What is the wall construction assembly?
  - CMU back up wall at sills and base of doors. Typical jambs and heads are at structure
  - Clarification that structure is concrete. Drawings will clarify this as part of Addendum
- Availability for the work
  - No construction work to take place while students are in school
  - Construction is limited to vacations, breaks, weekends and after school hours
  - School day ends 3pm
  - For school schedule see Project Manual page 01 10 00 4 of 7. Dates are subject to change and GC bidder shall verify with Facilities Manager.
    - Fall Break - Monday 10/14 through Friday 10/18
    - Thanksgiving Break - Monday 11/25 through Friday 11/29
    - Winter Break - Monday 12/23 through Friday 1/3
- Sill detail with trim – Revised detail issued in Addendum 1

### QUESTIONS AND NEXT STEPS

- Bid open date: 2:30pm Tuesday, September 10
  - Last Addendum – 2:30pm Thursday, September 5
  - Last date for questions: Tuesday, September 3
- Available funds for construction range:
  - \$225,000 to \$250,000
- Contract duration
  - Construction duration is 120 days. See Project Manual Page IB-3

# STOREFRONT WINDOW REPLACEMENT @WILLIAM GUSTE SCHOOL

PROJECT #ITB24-FAC-0015

ISSUED FOR 100% CONSTRUCTION DOCUMENTS - 7/5/2024




PROJECT NUMBER 2404.00

## STOREFRONT WINDOW REPLACEMENT @WILLIAM GUSTE SCHOOL


2625 THALIA STREET  
NEW ORLEANS, LOUISIANA 70113

ISSUES AND REVISIONS	DATE
ISSUED FOR CONSTRUCTION DOCUMENTS	07/05/2024
ADDENDUM 1	08/26/24

### AREA MAP

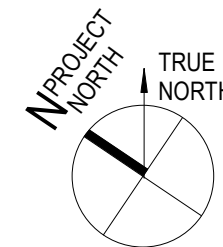

### SITE PLAN

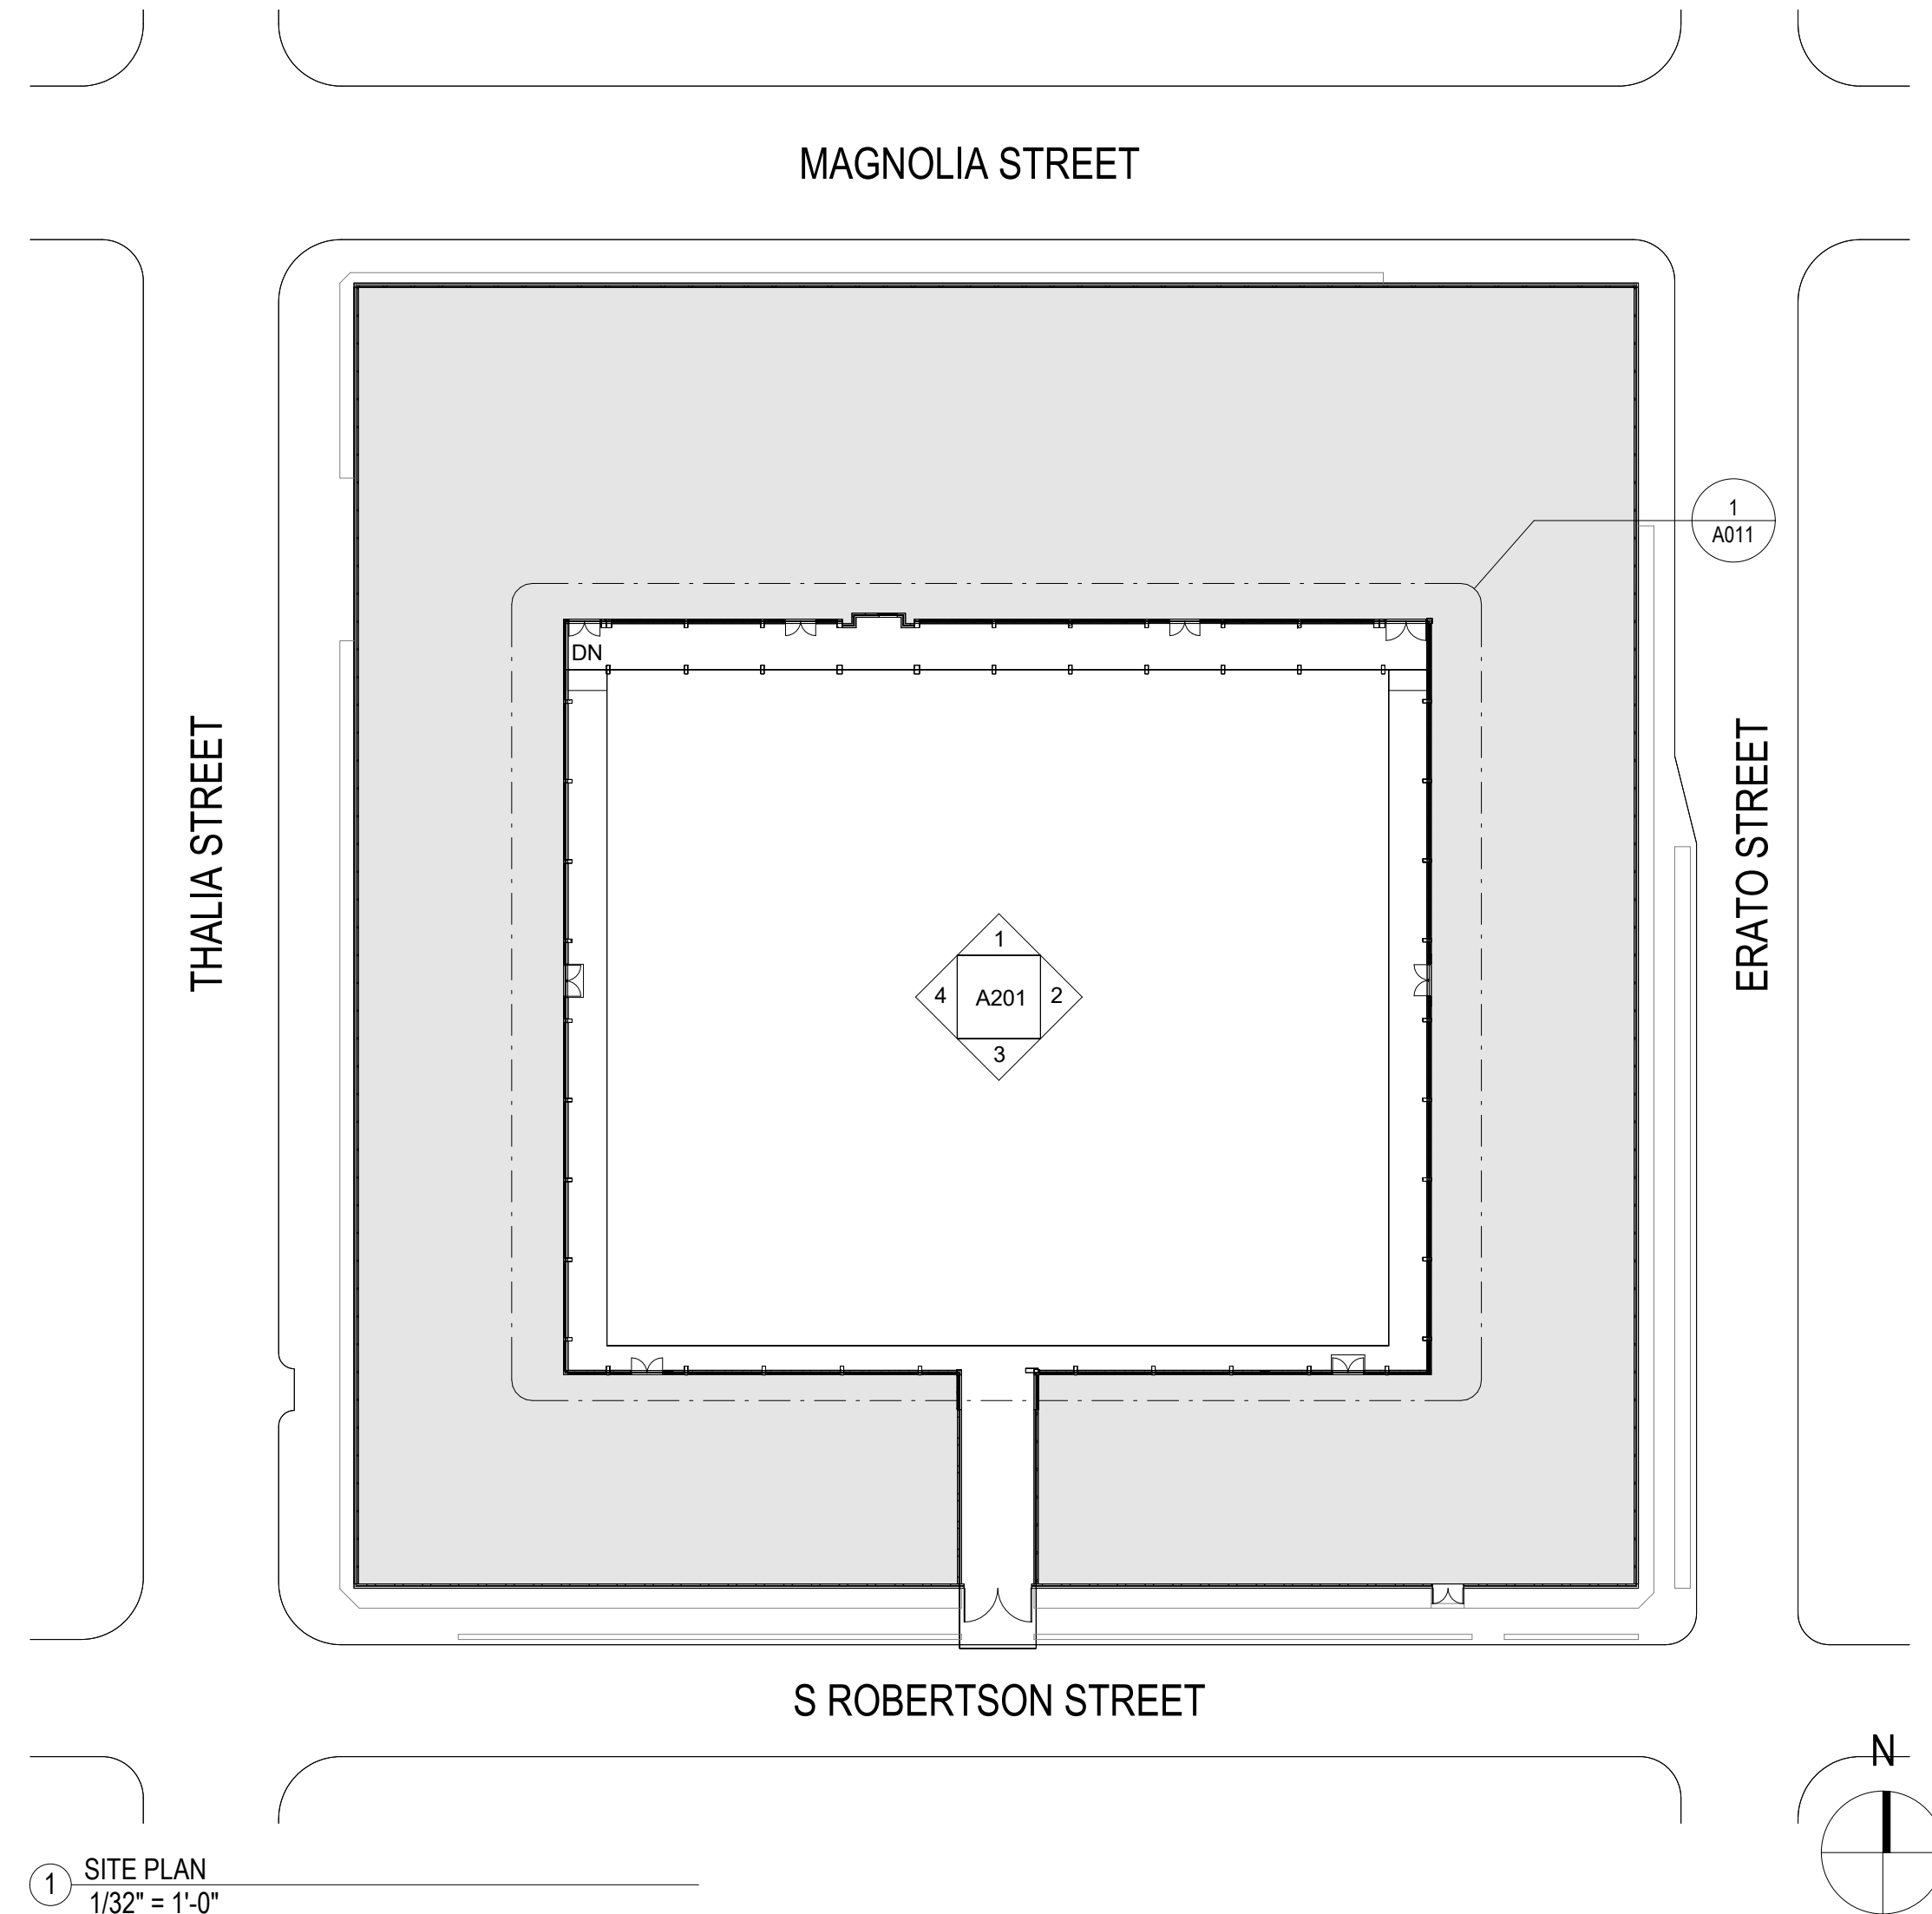


### ABBREVIATIONS

ABV	ABOVE	FLR	FLOOR (ING)	PLUMB	PLUMBING
A/C	AIR CONDITIONING	FD	FLOOR DRAIN	PLY WD	PLYWOOD
AFF	ABOVE FINISH FLOOR	GA	GAGE, GAUGE	PT	POINT
ADJ	ADJACENT	GALV	GALVANIZED	PTD	PAINTED
ALUM	ALUMINUM	GYP BD	GYP SUM BD	RAD	RADIUS
ARCH	ARCHITECT (URAL)	HVAC	HEATING/VENTILATING/AIR CONDITIONING	REF	REFERENCE
BLDG	BUILDING	HC	HOLLOW CORE	REFR	REFRIGERATOR
BLKG	BLOCKING	HM	HOLLOW METAL	REINF	REINFORCE (D) (ING)
BM	BEAM	HORIZ	HORIZONTAL	REV	REVISION (S) (ED)
CLG	CEILING	INCL	INCLUDE (ING)	RM	ROOM
CLR	CLEAR (ANCE)	INSUL	INSULATION	RO	ROUGH OPENING
COL	COLUMN	INT	INTERIOR	SIM	SIMILAR
CONC	CONCRETE	LAM	LAMINATE	S	SOUTH
CONT	CONTINUOUS	LAV	LAVATORY	SF	SQUARE FOOT
CRS	COURSES	MFR	MANUFACTURE (ER)	SPEC	SPECIFICATION
DTL	DETAIL	MLD	MOLDING	STD	STANDARD
DIAG	DIAGONAL	MTL	MATERIAL	STL	STEEL
DIAM	DIAMETER	MAX	MAXIMUM	STR	STRUCTURE
DIM	DIMENSION	MECH	MECHANIC (AL)	STRUCT	STRUCTURAL
DWG	DRAWING (S)	MIN	MINIMUM	SYM	SYMMETRY (ICAL)
E	EAST	MO	MEASURED OPENING	TYP	TYPICAL
ELEC	ELECTRIC (AL)	MT	MOUNT (ED) (ING)	UNO/UON	UNLESS NOTED OTHERWISE
EL	ELEVATION	N	NORTH	VB	VAPOR BARRIER
ELEV	ELEVATOR	NIC	NOT IN CONTRACT	VIF	VERIFY IN FIELD
EQ	EQUAL	NTS	NOT TO SCALE	VOJ	VERIFY ON JOBSITE
EQUIP	EQUIPMENT	OC	ON CENTER (S)	VERT	VERTICAL
ES	EACH SIDE	OPG	OPENING	WC	WATER CLOSET
EXIST	EXISTING	OPP	OPPOSITE	W	WEST
EXT	EXTERIOR	OH	OVERHEAD	WIN	WINDOW
EW	EACH WAY	P LAM	PLASTIC LAMINATE	WD	WOOD
FIN	FINISH (ED)			WH	WATER HEATER
FE	FIRE EXTINGUISHER				

### SYMBOL LEGEND

	BUILDING SECTION KEY		ENLARGED DETAIL PLAN KEY
	WALL SECTION KEY		COLUMN GRID IDENTIFIER
	SECTION DETAIL KEY		SPECIFIC KEYED NOTE IDENTIFIER
	EXTERIOR ELEVATION KEY		DOOR IDENTIFIER
	INTERIOR ELEVATION OR EXTERIOR ELEVATION DETAIL KEY		DOOR IDENTIFIER
			INTERIOR PARTITION IDENTIFIER
			CENTERLINE

### LOCATION MAP

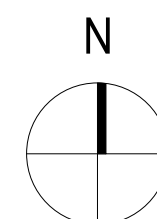

### PROJECT TEAM

#### OWNER

Orleans Parish School Board  
Opportunities Academy  
2625 Thalia Street  
New Orleans, LA 70113  
504.503.0008  
Kathleen Chen, Director of Facilities  
504.259.3204  
www.collegiateacademies.org

#### OWNER'S REP

Manning, APC  
650 Poydras St, Suite 1250  
New Orleans, LA 70130  
504.412.2000  
Ben Lacher, Senior Project Manager  
225.394.9950  
manning.xyz

#### ARCHITECT

Concordia LLC  
1610 Oretha Castle Haley Blvd.  
New Orleans, LA 70113  
504.569.1818  
Elizabeth Chen, Project Manager  
504.702.6825  
www.concordia.com

#### GENERAL CONTRACTOR

TBD

### SHEET INDEX

Drawing #	Drawing Title	Current Revision
G000	TITLE PAGE	
A011	DEMOLITION PLAN	1
A012	DEMO COURTYARD ELEVATIONS	
A101	PLAN	
A201	REVISED ELEVATIONS	
A301	OPENING ELEVATIONS	
A302	OPENING SCHEDULE AND DETAILS	1

### PROJECT INFORMATION

OPSB PROJECT NUMBER: ITB24-FAC-0015

ZONING DISTRICT:  
HU-RM2  
HISTORIC URBAN MULTI-FAMILY RESIDENTIAL DISTRICT

OVERLAY ZONING DISTRICT:  
RESIDENTIAL SHORT TERM RENTAL INTERIM ZONING DISTRICT  
BED AND BREAKFAST INTERIM ZONING DISTRICT  
COMMERCIAL SHORT TERM RENTAL INTERIM ZONING DISTRICT

SITE DIMENSIONS:  
LOT AREA: 65,040 SF (EXISTING TO REMAIN)  
BUILDING FOOTPRINT: 80,369SF (EXISTING TO REMAIN)

OCCUPANCY TYPE:  
NO CHANGE OF OCCUPANCY  
GROUP I-4: INSTITUTIONAL  
DAY CARE FACILITIES: ADULT DAY CARE

APPLICABLE CODES:  
• IBC2021  
• IEBC2021  
• IECC2021  
• ADAAG

### PROJECT DESCRIPTION

THIS PROJECT INVOLVES THE REPLACEMENT OF THE EXISTING SINGLE-PANEL ALUMINUM STOREFRONT WINDOWS ALONG THE FIRST-FLOOR COURTYARD WITH NEW DOUBLE-GLAZED STOREFRONT WINDOWS. 26 WINDOWS BAYS WILL BE REPLACED.

- REMOVE EXISTING STOREFRONT SYSTEM AT THE END OF ITS LIFE CYCLE. EXISTING SYSTEM HAS SLIDING OPERABLE COMPONENTS
- REPLACE WITH NEW STOREFRONT SYSTEM IN EXISTING OPENINGS.
  - GLAZED PANELS TO BE FIXED/NON-OPERABLE
- EXISTING HVAC SYSTEM TO REMAIN WITH MINIMAL WORK LIMITED TO RECONFIGURING EXISTING DUCTING AND ROUTED THROUGH NEW STOREFRONT SYSTEM AND NEW LOUVERS IN EXISTING LOCATION.

COORDINATE PHASING WITH SCHOOL SCHEDULE. IT IS THE INTENTION FOR THE WORK TO BE PERFORMED DURING SCHOOL BREAKS, WEEKENDS OR AFTER HOURS. COORDINATE WITH CHARTER, OWNER, OWNER'S REP. SEE SPECIFICATIONS FOR SCHEDULE IN REGARDS TO WHEN WORK CAN BE PERFORMED.

SCOPE OF WORK DOES NOT INCLUDE:

- ELECTRICAL WORK
- PLUMBING WORK
- STRUCTURAL WORK
- SITE WORK/LANDSCAPING/GROUND COVER
- NO CHANGE IN AREA/BUILDING FOOTPRINT

SHEET TITLE

### TITLE PAGE

# G000

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Storefront Schedule					
Mark	R.O. Width (VIF)	R.O. Height (VIF)	DETAIL SET	OPENING TYPE	Notes
N1	6'-5"	6'-3 1/4"	N/A	N/A	NOT IN SCOPE
N2	14'-0"	6'-3 1/4"	N/A	N/A	NOT IN SCOPE
N3	14'-0"	6'-3 1/4"	N/A	N/A	NOT IN SCOPE
N4	14'-0"	6'-3 1/4"	N/A	N/A	NOT IN SCOPE
N5	14'-0"	6'-3 1/4"	N/A	N/A	NOT IN SCOPE
N6	14'-0"	6'-3 1/4"	N/A	N/A	NOT IN SCOPE
N7	14'-0"	6'-3 1/4"	N/A	N/A	NOT IN SCOPE
N8	14'-0"	6'-3 1/4"	N/A	N/A	NOT IN SCOPE
N9	14'-0"	6'-3 1/4"	N/A	N/A	NOT IN SCOPE
N10	14'-0"	6'-3 1/4"	N/A	N/A	NOT IN SCOPE
N11	14'-0"	6'-3 1/4"	N/A	N/A	NOT IN SCOPE
E1	14'-7 1/2"	6'-3 1/4"	1	TYPE 2	SAFETY GLAZING AT SECTION ADJACENT TO DOOR. SEE ELEVATIONS
E2	14'-7 3/4"	6'-3 1/4"	1	TYPE 2	
E3	14'-7 3/4"	6'-3 1/4"	1	TYPE 2	
E4	14'-7 3/4"	6'-3 1/4"	1	TYPE 2	
E5	14'-7 3/4"	9'-0"	1, 2, 3	TYPE 3B MIRR	RECONFIGURE EXISTING DUCT IN NEW LOUVER INFILL PANEL
E6	14'-7 3/4"	6'-3 1/4"	1	TYPE 2	
E7	14'-7 3/4"	6'-3 1/4"	1	TYPE 2	
E8	14'-7 3/4"	6'-3 1/4"	1	TYPE 2	
E9	14'-7 3/4"	6'-3 1/4"	1, 3	TYPE 2A	RECONFIGURE EXISTING DUCT IN NEW LOUVER INFILL PANEL
E10	5'-9"	6'-3 1/4"	1	TYPE 1	
S1	7'-4 1/2"	6'-3 1/4"	1	TYPE 1	
S2	14'-3 1/2"	9'-0"	1, 2	TYPE 3	
S3	14'-3 1/2"	6'-3 1/4"	1, 3	TYPE 2A	RECONFIGURE EXISTING DUCT IN NEW LOUVER INFILL PANEL
S4	14'-3 1/2"	6'-3 1/4"	N/A	N/A	NOT IN SCOPE
S5	14'-3 1/2"	6'-3 1/4"	N/A	N/A	NOT IN SCOPE
S6	6'-8"	6'-3 1/4"	N/A	N/A	NOT IN SCOPE
S7	14'-4"	6'-3 1/4"	N/A	N/A	NOT IN SCOPE
S8	14'-4"	6'-3 1/4"	N/A	N/A	NOT IN SCOPE
S9	14'-3 1/4"	6'-3 1/4"	1	TYPE 2	
S10	14'-4"	9'-0"	1, 2, 3	TYPE 3A	RECONFIGURE EXISTING DUCT IN NEW LOUVER INFILL PANEL
S11	7'-5"	6'-3 1/4"	1	TYPE 1	
W1	5'-8"	6'-3 1/4"	1	TYPE 1	
W2	14'-7 1/2"	6'-3 1/4"	1, 3	TYPE 2A	RECONFIGURE EXISTING DUCT IN NEW LOUVER INFILL PANEL
W3	14'-8"	6'-3 1/4"	1	TYPE 2	
W4	14'-8"	6'-3 1/4"	1	TYPE 2	
W5	14'-7 1/4"	6'-3 1/4"	1	TYPE 2	
W6	14'-8"	9'-0"	1, 2, 3	TYPE 3B	RECONFIGURE EXISTING DUCT IN NEW LOUVER INFILL PANEL
W7	14'-7"	6'-3 1/4"	1	TYPE 2	
W8	14'-9"	6'-3 1/4"	1	TYPE 2	
W9	14'-8"	6'-3 1/4"	1	TYPE 2	
W10	14'-8"	6'-3 1/4"	1	TYPE 2	SAFETY GLAZING AT OPTIONAL LOCATION. SEE ELEVATIONS

DOOR SCHEDULE					
Mark	Door Type	Door Width	Door Height	Hardware Set	Finish
NA	Existing to Remain	Existing to Remain	Existing to Remain	Existing to Remain	Existing to Remain
NB	Existing to Remain	Existing to Remain	Existing to Remain	Existing to Remain	Existing to Remain
NC	Existing to Remain	Existing to Remain	Existing to Remain	Existing to Remain	Existing to Remain
ND	Existing to Remain	Existing to Remain	Existing to Remain	Existing to Remain	Existing to Remain
EA	A	6'-0" VIF	7'-0" VIF	HW1	PVDF. COLOR TO MATCH CLEAR ANOD
SA	A	6'-0" VIF	7'-0" VIF	HW1	PVDF. COLOR TO MATCH CLEAR ANOD
SB	A	6'-0" VIF	7'-0" VIF	HW1	PVDF. COLOR TO MATCH CLEAR ANOD
WA	A	6'-0" VIF	7'-0" VIF	HW1	PVDF. COLOR TO MATCH CLEAR ANOD

**HARDWARE SETS**

**HW1**

- ELECTRIFIED PANIC DEVICE EACH LEAF - INTERIOR
- LEVER WITH CYLINDER EACH LEAF - EXTERIOR
- POWER SUPPLY (FOR FUTURE AUTOMATIC DOOR OPENER)
- OVERHEAD DOOR CLOSER WITH AUXILIARY STOP EACH LEAF
- THRESHOLD
- DOOR SWEEP EACH LEAF
- SILENCERS


NOTE: ALL HARDWARE TO BE COMPATIBLE WITH FUTURE RECONFIGURATION TO ADD AUTOMATIC DOOR OPERATOR. COORDINATE WITH STOREFRONT AND HARDWARE MANUF'R. FUTURE AUTOMATIC DOOR OPERATOR NOT PART OF THIS PROJECT'S SCOPE

**DOOR GENERAL NOTES**

- DOORS TO COMPLY WITH THE AMERICANS WITH DISABILITIES ACT ACCESSIBILITY GUIDELINES
- DOORS TO COMPLY WITH ALL LIFE SAFETY CODES. PANIC HARDWARE TO BE OPERABLE DURING BUILDING USE AND AFTER HOURS
- LOCKING MECHANISMS TO BE OVERRIDDEN BY PANIC DEVICES TO COMPLY WITH LIFE SAFETY CODES
- THRESHOLDS SHALL BE NO HIGHER THAN 1/2" AFF. EDGE TO BE BEVELED WITH A RISE/RUN SLOPE NO GREATER THAN 1:2
- DOOR HARDWARE SHALL BE MOUNTED WITHIN ADAAG REACH RANGES
- DOORS SHALL BE OPERABLE WITH A MAXIMUM EFFORT AS INDICATED BY ADAAG
- DOOR CLOSERS SHALL HAVE A CLOSING SPEED IN ACCORDANCE WITH ADAAG
- ALL DOORS TO BE PROVIDED WITH SILENCERS AND STOPS
- STOREFRONT SYSTEM AND DOORS SHALL BE INSTALLED SUCH THAT MATERIALS, HARDWARE AND CONFIGURATION SUPPORT EASE OF FUTURE RECONFIGURATION FOR ADA ACCESSIBILITY INCLUDING AUTOMATIC DOOR OPENER WITH ACTIVATION BUTTON. COORDINATE HARDWARE WITH MANUF'R FOR FUTURE RECONFIGURATION. CURRENT CONSIDERATIONS INCLUDE BUT ARE NOT LIMITED TO THRESHOLDS, ELECTRIFIED STRIKE, ELECTRIFIED PANIC BAR, CLOSERS, OPERATIONAL FORCE AND MANEUVERING CLEARANCES.

**OPENINGS GENERAL NOTES**

- G.C. AND SUBS TO VERIFY ALL DIMENSIONS IN FIELD ESPECIALLY ROUGH OPENINGS WHERE CRITICAL TO NEW STOREFRONT SIZE
- VIF ALL EXISTING SILL HEIGHTS AND PROPER SLOPE FOR DRAINAGE
- VERIFY GOOD CONDITION OF MASONRY ADJACENT TO STOREFRONT SYSTEM. REPAIR MASONRY IF DAMAGED, CRACKED OR IF WEATHER BARRIER IS COMPROMISED
- AFTER DEMOLITION OF EXISTING STOREFRONT SYSTEM, NOTIFY ARCHITECT FOR OBSERVATION OF EXISTING CONDITIONS WHICH ARE CURRENTLY INACCESSIBLE
- COORDINATE NEW LOUVERS WITH NEW INSTALLED STOREFRONT. VIF NEW STOREFRONT DIMENSIONS
- STOREFRONT SYSTEM TO COMPLY WITH ALL APPLICABLE CODES INCLUDING BASIC WIND LOAD AND MISSILE IMPACT TESTING
- IMPACT RATED LOUVER TO COMPLY WITH ALL APPLICABLE CODES INCLUDING BASIC WIND SPEED
- REPAIR IN KIND FINISHES DAMAGED OR EXPOSED DUE TO INSTALLATION OF NEW STOREFRONT SYSTEM
- MECHANICAL SUB AND G.C. TO VERIFY AND MATCH EXISTING NET FREE AREA OF LOUVER TO ENSURE PROPER OPERATION OF HVAC UNIT ASSOCIATED WITH NEW LOUVER
- MECHANICAL SUB AND G.C. TO PROVIDE COMPATIBLE MATERIALS FOR RECONFIGURATION OF EXISTING DUCTWORK TO NEW LOUVERS
- G.C. IS RESPONSIBLE FOR ENSURING THAT HVAC UNITS RECONFIGURED AS PART OF THIS SCOPE ARE RETURNED IN SAME OR BETTER OPERATIONAL CONDITION. PROPER OPERATION OF HVAC UNITS TO BE VERIFIED BEFORE AND AFTER WORK IS COMPLETED. G.C. TO REPAIR UNIT IF DAMAGED DUE TO SCOPE OF WORK
- RUN CONDUIT FOR FUTURE AUTOMATIC DOOR OPERATOR. COORDINATE WITH STOREFRONT AND HARDWARE MANUF'R. AUTOMATIC DOOR OPERATOR NOT PART OF THIS PROJECT'S SCOPE
- GLAZING THAT IS REQUIRED TO BE SAFETY GLAZING SHALL BE LABELED AS SUCH AND SHALL BE INSULATING LAMINATING UNITS (TYPE ILG#1) TO MEET REQUIREMENTS FOR SAFETY GLAZING, WIND SPEED AND LARGE MISSILE IMPACT
- ALL OTHER EXTERIOR GLAZING SHALL BE INSULATING LAMINATING UNITS (TYPE ILG#1) AND TO MEET REQUIREMENTS FOR WIND SPEED.
- REFERENCE CODES
  - A. THIS PROJECT IS IN RISK CATEGORY 3
  - B. SAFETY GLAZING SHALL BE DETERMINED BY IBC2406.2 IMPACT TEST FOR SAFETY GLAZING.
  - C. WIND SPEED SHALL BE DETERMINED BY IBC1609.3(2) AND ASCE 7 WIND SPEED FOR RISK CATEGORY III BUILDINGS: <160VMPH
  - D. LARGE MISSILE IMPACT GLAZING SHALL BE DETERMINED BY IBC 1609.2
  - E. LOUVERS SHALL MEET AMCA 540 AND IBC 1609.2.1 <160VMPH

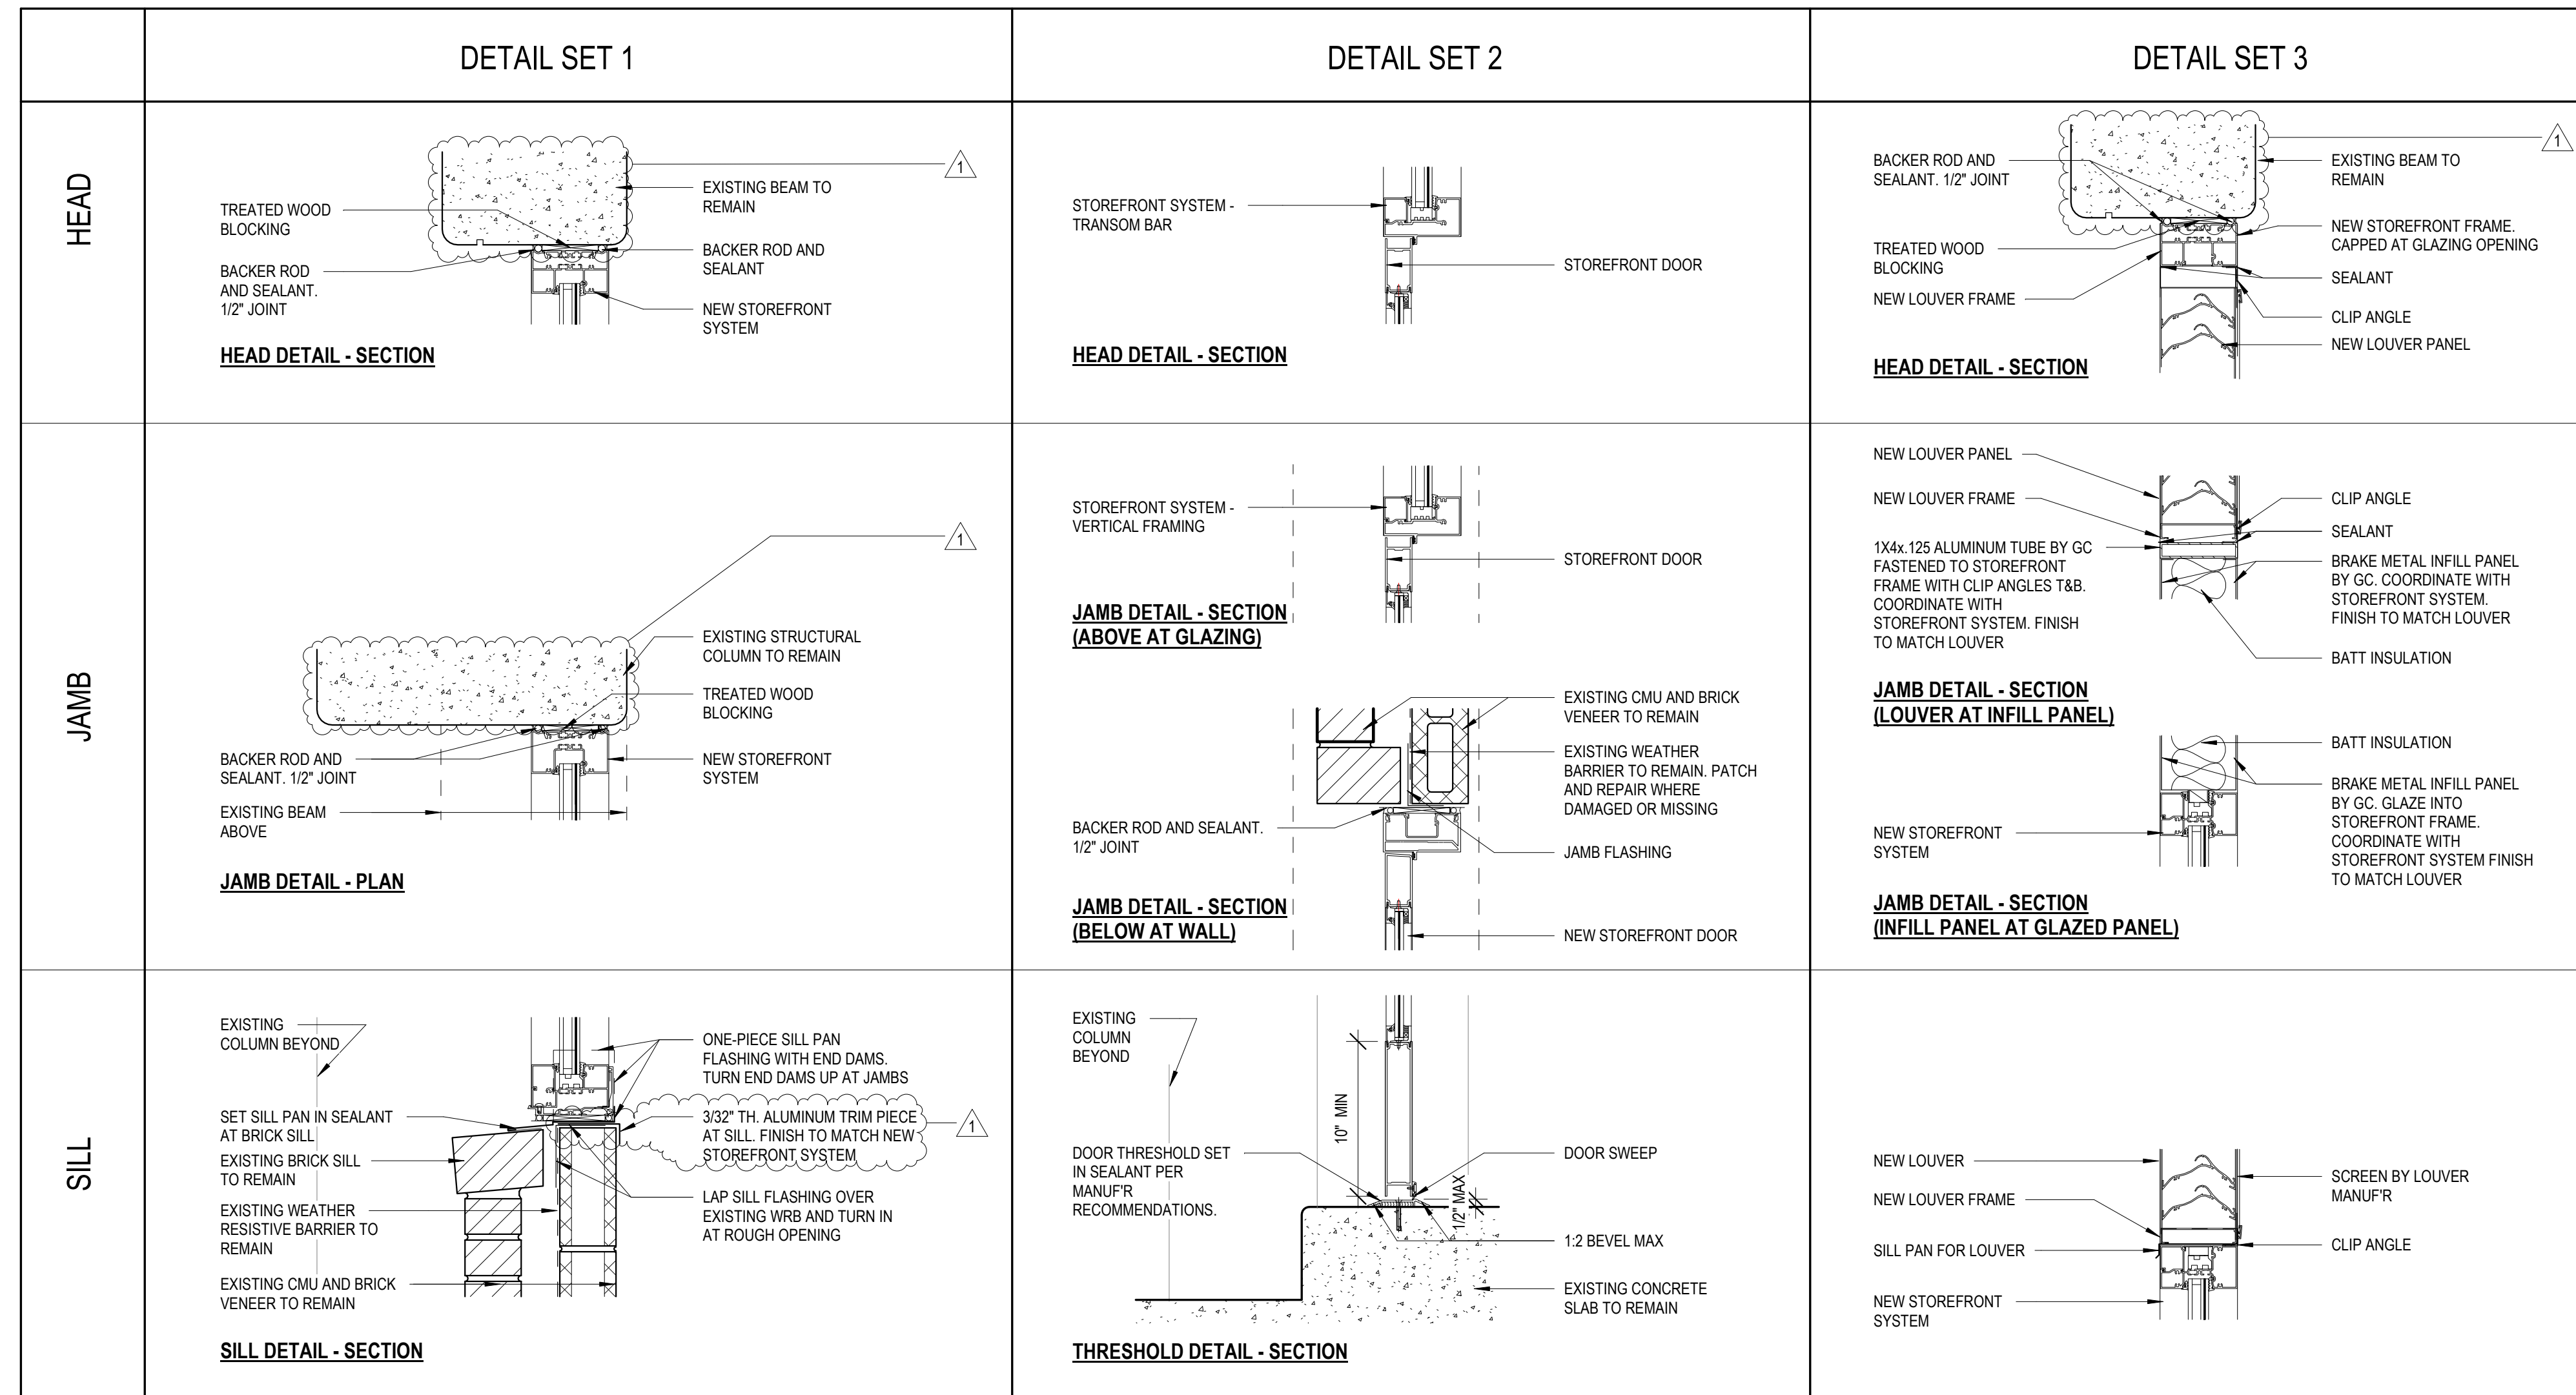

① STOREFRONT DETAIL - SET 1  
1 1/2" = 1'-0"

② STOREFRONT DETAIL - DOOR - SET 2  
1 1/2" = 1'-0"

③ STOREFRONT DETAIL - LOUVER - SET 3  
1 1/2" = 1'-0"

STOREFRONT WINDOW REPLACEMENT @WILLIAM GUSTE SCHOOL

2625 THALIA STREET  
NEW ORLEANS, LOUISIANA 70113

ISSUES AND REVISIONS	DATE
ISSUED FOR CONSTRUCTION DOCUMENTS	07/05/24
ADDENDUM 1	08/26/24

DRAWING NOT FOR CONSTRUCTION

SHEET TITLE

OPENING SCHEDULE AND DETAILS

A302

ALL DRAWINGS AND WRITTEN MATERIAL APPEARING HEREIN CONSTITUTE ORIGINAL AND UNPUBLISHED WORK OF THE ARCHITECT AND MAY NOT BE DUPLICATED, USED, OR DISCLOSED WITHOUT WRITTEN CONSENT OF THE ARCHITECT